
TRIBUTARY TO INDIAN CREEK (PROJECT B) SRF SPONSORED PROJECT CITY OF NEVADA IOWA

NEVADA, IOWA 2025

CERTIFICATION

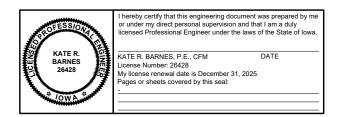







LOCATION MAP



HRGreen

8710 EARHART LANE SW | CEDAR RAPIDS, IOWA 52404 Phone: 319.841.4000 | Toll Free: 800.728.7805 | Fax: 319.841.4012 | HRGreen.com

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C203	PLAN & PROFILE - STA 19+80 TO 25+60
C204	RESTORATION - STA 9+80 TO 14+00
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FINAL PLANS


APPROVED: KB JOB NUMBER: 191900.03

DATE	BY	REVISION DESCRIPTION



TRIBUTARY TO INDIAN CREEK (PROJECT B) CITY OF NEVEDA NEVADA, IOWA

GENERAL COVER SHEET

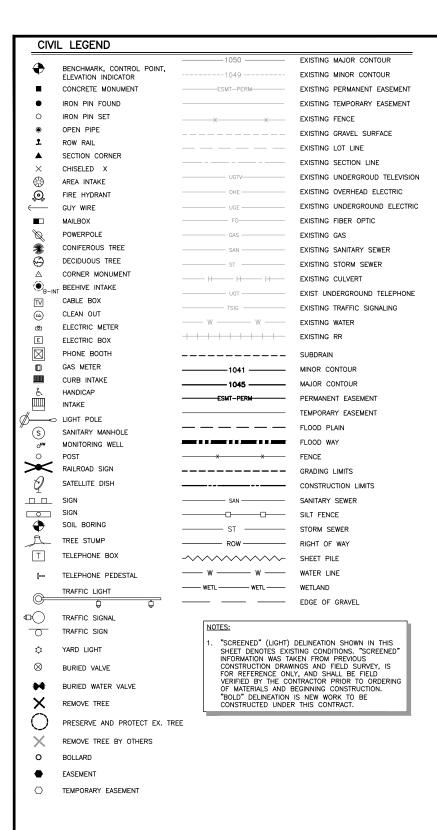

THE IOWA STATEWIDE URBAN DESIGN AND SPECIFICATIONS (SUDAS) LATEST REVISIONS - 2023 EDITION. APPLICABLE SUPPLEMENTAL SPECIFICATIONS. AND SPECIAL PROVISIONS, SHALL APPLY TO CONSTRUCTION ON THIS PROJECT.

MATERIAL LEGEND

EARTH, BACKFILL



SAND, GRAVEL CONCRETE (PLAN)



GRAVEL FILL, GRAVEL PAVING





CAST IN PLACE CONCRETE, PRECAST CONCRETE,



CONCRETE MASONRY UNITS



BRICK MASONRY UNITS ACC PAVING IN SECTION



INSULATION: NON-RIGID, BATT



INSULATION: RIGID



ROUGH CARPENTRY





SEEDED AREA

SYMBOL LEGEND



TRUE NORTH ARROW:
ORIENTATION IS SURVEYED TO TRUE NORTH OR AS CLOSE TO TRUE NORTH AS KNOWN DATA.



PLAN NORTH ARROW: ORIENTATION IS CLOSEST TO TRUE NORTH AND INCREASES
COMMUNICATION WHEN ADDRESSING
SIDES OF A STRUCTURE.



CIVIL SCALE BAR

BLDG DETAIL OR SECTION

SCALE: TO SCALE

DETAIL (NOT TO SCALE)

SCALE: NONE

1. NOTES ASSOCIATED WITH SHEET, PLAN, ELEVATION, SECTION OR DETAIL.



DETAIL INDICATOR



SECTION INDICATOR



ELEVATION INDICATOR



MATCH LINE INDICATOR



CONTRACT TERMINATOR REVISION MARKER



VENDOR CONTRACTOR

NOT ALL ABBREVIATIONS OR SYMBOLS SHOWN IN THESE LISTS MAY BE USED IN THIS PROJECT. CONTACT ARCHITECT OR ENGINEER FOR CLARIFICATION OF ANY DISCREPANCIES.

GENERAL NOTES:

- 1. SITE GRADING SHALL NOT PROCEED UNTIL EROSION CONTROL MEASURES HAVE BEEN
- 2. THE CONTRACTOR SHALL COMPLY TO THE FULLEST EXTENT WITH THE LATEST OSHA STANDARDS AND REGULATIONS, OR ANY OTHER AGENCY HAVING JURISDICTION FOR EXCAVATION AND TRENCHING PROCEDURES. THE CONTRACTOR IS RESPONSIBLE FOR DETERMINING THE "MEANS AND METHODS" REQUIRED TO MEET THE INTENT AND PERFORMANCE CRITERA OF OSHA, AS WELL AS ANY OTHER ENTITY THAT HAS JURISDICTION FOR EXCAVATION AND/OR TRENCHING PROCEDURES.
- 3. THE CONTRACTOR IS RESPONSIBLE FOR VERIFICATION OF EXISTING TOPOGRAPHIC INFORMATION AND UTILITY INVERT ELEVATIONS PRIOR TO COMMENCEMENT OF ANY CONSTRUCTION. ANY DISCREPANCIES THAT MAY AFFECT THE PUBLIC SAFETY OR PROJECT COST MUST BE IDENTIFIED TO THE ENGINEER IN WRITING IMMEDIATELY, PROCEEDING W CONSTRUCTION WITHOUT NOTIFICATION IS DONE SO AT THE CONTRACTOR'S OWN RISK.
- 4. IN CASE OF DISCREPANCIES BETWEEN PLANS OR RELATIVE TO OTHER PLANS, THE SITE PLAN WILL TAKE PRECEDENCE. IMMEDIATELY NOTIFY THE ENGINEER IN WRITING OF ANY
- 5. ALL EXISTING STRUCTURES, UNLESS OTHERWISE NOTED TO REMAIN, FENCING, TREES, & ETC., WITHIN CONSTRUCTION AREA SHALL BE REMOVED & DISPOSED OF OFF SITE. NO ON SITE BURNING WILL BE ALLOWED
- 6. GENERAL CONTRACTOR SHALL NOTIFY ALL UTILITY COMPANIES HAVING UNDERGROUND UTILITIES ON SITE OR IN RIGHT-OF-WAY PRIOR TO EXCAVATION. CONTRACTOR SHALL CONTACT UTILITY LOCATING COMPANY AND LOCATE ALL UTILITIES PRIOR TO GRADING
- 7. PART OF THE PROPOSED PROJECT IS LOCATED WITHIN WATERS OF THE UNITED STATES.
- 8. THE CONTRACTOR SHALL CONFINE THEIR GRADING OPERATIONS TO WITHIN CONSTRUCTION LIMITS AND EASEMENTS SHOWN ON THE PLANS. ANY DAMAGE TO PROPERTIES OUTSIDE THE SITE BOUNDARY SHALL BE AT THE SOLE RESPONSIBILITY OF THE CONTRACTOR.
- 9. THE CONTRACTOR SHALL APPLY NECESSARY MOISTURE CONTROL TO THE CONSTRUCTION AREA AND HAUL ROADS TO PREVENT THE SPREAD OF DUST.
- 10. ALL FIELD TILES ENCOUNTERED SHALL BE REPLACED AND/OR CONNECTED TO THE STORM SEWER SYSTEM AND LOCATED AND IDENTIFIED ON THE RECORD PLANS BY THE
- 11. THE CONTRACTOR SHALL NOT DISTURB DESIRABLE GRASS AREAS AND DESIRABLE TREES OUTSIDE THE CONSTRUCTION LIMITS. THE CONTRACTOR SHALL NOT BE PERMITTED TO PARK OR SERVICE VEHICLES AND EQUIPMENT OR USE THESE AREAS FOR STORAGE OR STORAGE, PARKING AND SERVICE AREAS WILL BE SUBJECT TO THE APPROVAL OF THE OWNER.
- 12. THE CONTRACTOR IS RESPONSIBLE FOR REPLACING ANY AREAS OF PAVEMENT OR SIDEWALK NOT TO BE REMOVED THAT IS DAMAGED DUE TO OPERATING EQUIPMENT ON THE PAVEMENT OR SIDEWALK.
- 13. THE CONTRACTOR MAY BE REQUIRED TO PLACE TEMPORARY WARNING DEVICES AND SAFETY FENCE AT CERTAIN LOCATIONS WHERE REPLACEMENT FEATURES ARE NOT INSTALLED THE SAME DAY, AS DIRECTED BY THE ENGINEER OR THE OWNER.
- 14. FIELD VERIFY ELEVATIONS AND LOCATIONS OF ALL CONNECTIONS TO EXISTING UTILITIES
- 15. WHERE PUBLIC UTILITY FIXTURES ARE SHOWN AS EXISTING ON THE PLANS OR WHERE FOBLIC VILLIA THORES ARE SHOWN AS EASIMO ON THE PARTS OF ENCOUNTERED WITHIN THE CONSTRUCTION AREA, IT SHALL BE THE RESPONSIBILITY OF THE CONTRACTOR TO NOTIFY THE OWNERS OF THOSE UTILITIES PRIOR TO THE BEGINNING OF ANY CONSTRUCTION. THE CONTRACTOR SHALL AFFORD ACCESS TO THESE FACILITIES OF ANY CONSTRUCTION. THE CUNTRACTOR SHALL AFFORD ACCESS TO THESE FACILITIES FOR NECESSARY MODIFICATION OF SERVICES. UNDERGROUND FACILITIES, STRUCTURES, AND UTILITIES HAVE BEEN PLOTTED FROM AVAILABLE SURVEYS AND RECORDS AND THEREFORE, THEIR LOCATIONS MUST BE CONSIDERED APPROXIMATE ONLY. IT IS POSSIBLE THERE MAY BE OTHERS. THE EXISTENCE OF WHICH IS PRESENTLY NOT KNOWN OR SHOWN, IT IS THE CONTRACTORS RESPONSIBILITY TO DETERMINE THEIR EXISTENCE AND EXACT LOCATIONS AND TO AVOID DAMAGE THERETO. NO CLAIMS FOR ADDITIONAL COMPENSATION WILL BE ALLOWED TO THE CONTRACTOR FOR ANY INTERFERENCE OR DELAY CAUSED BY SUCH WORK
- 16. ROOF DRAINS, FOUNDATION DRAINS, AND OTHER CLEAN WATER CONNECTIONS TO THE SANITARY SEWER SYSTEM ARE PROHIBITED.
- 17. GENERAL CONTRACTOR SHALL HAVE APPROVAL OF ALL GOVERNING AGENCIES HAVING JURISDICTION OVER THIS SYSTEM PRIOR TO INSTALLATION.


NEVADA, IOWA

18. ALL EXISTING UTILITIES TO BE FIELD VERIFIED PRIOR TO CONSTRUCTION.

FINAL PLANS

TRIBUTARY TO INDIAN CREEK (PROJECT B) **GENERAL**

BAR IS ONE INCH ON OFFICIAL DRAWINGS. APPROVED: KB JOB NUMBER: 191900.03 CAD DATE: 1/13/2025 11:06:35 AM CAD FILE: J:\2019\191900\CAD - Tributary\Dwgs\G\G001 GEN NOTES.dwg

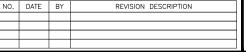



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Column			DEG DEGREE		MAU MAKEUP AIR UNIT			
The content of the	ACT	ACOUSTIC CEILING TILE	DEPT DEPARTMENT	GEN GENERATOR	MBH ONE THOUSAND BTUH		VC VICTAULIC COUPLING	
Column	AD	ACCESS DOOR, AIR DRYER		GFR GROUND FAULT RELAY		RD ROOF DRAIN	VCT VINYL COMPOSITION TILE	
Company			DI DUCTILE IRON			RED REDUCER		
## Committed Com			DIM DIMENSION	GL GLASS	MEZZ MEZZANINE		VENT VENTILATION	
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West Company	ALT	ALTERNATE				RM ROOM		
Column C			DWL DOWEL					
## Add Section Control				HCAP HANDICAP (PED)	MOCP MAXIMUM OVERCURRENT PROTECTION	RPM REVOLUTIONS PER MINUTE		
Company	ANSI	AMERICAN NATIONAL STANDARDS INSTITUTE		HDPE HIGH DENSITY POLYETHYLENE	MTD MOUNTED	RS RAW SEWAGE	WB WET BULB	
Column C								
A	ASHRAE		ECP ENVIRONMENTAL CONTROL PANEL		MW MASONRY WALL	S&F SECURITY & FIRE PNL		
Part		AIR CONDITIONING ENGINEERS	EER ENERGY EFFICIENCY RATIO	HM HOLLOW METAL		SA SUPPLY AIR	WG WATER GAUGE	
## WITCH PARTY AND CO. C. C. C. C. C. C. C.	ASTM		EF EXHAUST FAN, EACH FACE		NC NOISE CRITERIA, NORMALLY CLOSED	SAT SATURATION		
A	AT ATS		EG EXHAUST GRILLE, EQUIPMENT GENERATOR	HOR HORIZONTAL				
March Color Colo	AVG	AVERAGE	EL ELEVATION	HPG HIGH PRESSURE GAS	NFPA NATIONAL FIRE PROTECTION ASSOCIATION	SCH SCHEDULE	WS WALL SLEEVE, WATERSTOP, WATER SURFACE	
Column C	AWG			HR HOUR	NL NIGHTLIGHT	SEER SEASONAL ENERGY EFFICIENCY RATIO	WSHP WATER SOURCE HEAT PUMP	
Second Continue		BACK TO BACK (OF CURBS)	EMBED EMBEDMENT	HSGL HEAT STRENGTHENED GLASS				
Section Control Cont	BC	BARE COPPER	ENG ENGINEER	HT HEIGHT	NPT NATIONAL PIPE THREAD	SF SUPPLY FAN, SQUARE FOOT		
December Class				HTR HEATER	NRP NON-REMOVABLE PIN	SH SHIELDED, SHOWER, SHEET		
Part Control Part Part Control Part Part Control Part Part Control Part Part Control Part Pa		BACKDRAFT DAMPER	EQMT EQUIPMENT		NTS NOT TO SCALE			
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## SETTING PROPERTY OF THE PRO	BFV			HWP HEATING WATER PUMP	OBD OPPOSED BLADE DAMPER	SIM SIMILAR		
1								
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E-2-12 E			EXP EXPANSION		OPNG OPENING			
SEC CASH C						SR SUPPLY REGISTER		
EN RE VER GOR	BRK	BRICK	F DEGREES FAHRENHEIT, FLUORIDE	ID INSIDE DIAMETER	D DOLE DUMP	SSH SAFETY SHOWER		
Fig. Sect.	BTUH	BTU PER HOUR		I/F, IF INSIDE FACE	PART PARTIAL	SST SATURATED SUCTION TEMPERATURE		
Control Cont			FAC FLANGED ADAPTOR COUPLING					
Part		CONDUIT OF ONE O CTOUCTURE CLARE		INF INFLUENT		STL STEEL		
Column		CAPACITY		INT INTERIOR	PCF POUNDS PER CUBIC FOOT	SW SWITCH, SAMPLING		
COLLING DITIONER OILS ON COLLING DITIONER O			FDGGF FREE DRAINING GRADED	INVI INVERI	PD PRESSURE DROP			
Color Colo	CD	CEILING DIFFUSER	FDN FOUNDATION			TACH TACHOMETER		
CONTROLLAND TO PACK CLAN IN PAC	CFM	CUBIC FEET PER MINUTE	FEC FIRE EXTINGUISHER CABINET		PERP PERPENDICULAR	TBS THICKENED BLENDED SLUDGE		
OF CALL LOSS ON HER PART OF THE PRESENT OF THE PART OF	CI	CAST IRON	FF FINISHED FLOOR		PH PHASE	TD TEMPERATURE DIFFERENCE		
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CPT CONTROL POWER TRANSFORMER, CARPET COPY CHUCRINASTER CAPPET FT FEET, FLOW TRANSMITTER LONG LOGKOUT STOPP PUSH—BUTTON UNFORM MISTER COEFFICIENT COVER CHUCRINASTER POLICY CHUCRINASTER COEFFICIENT UNFORM MISTER COEFFICIENT UNFORM MISTER COEFFICIENT COUNTING COUNTING COEFFICIENT COUNTING COEFFICIENT COUNTING COUNTING COUNTING COUNTING COUNTING COUNTIN	CP	CORNER POINT	FRP FIBERGLASS REINFORCED PLASTIC OR PNL					
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ITEM NUMBER	ITEM CODE	BID ITEM	QUANTITY	UNITS
DIVISION 1 -	GENERAL			
1	1070-206-A	TEMPORARY TRAFIC CONTROL	1	LS
DIVISION 2 -	EXCAVATION			
2	2010-108-C	CLEAR AND GRUBBING, TREE, BRUSH, AND ROCK REMOVAL	1	LS
3	TOPSOIL, ONSITE, 6-INCH DEPTH (STRIP, SALVAGE, AND RESPREAD)		400	CY
4	2010-108-E	EXCAVATION, CLASS 13, HAUL OFF-SITE	75	CY
5	2010-108-E	EXCAVATION, CLASS 13, RESPREAD OFF-SITE	75	CY
6	2010-108-E	EXCAVATION, CLASS 13, REUSE ON-SITE	178	CY
DIVISION 9 -	SITE WORK A	ND EROSION CONTROL	•	
7	9010-108-A	PERMANENT CONVENTIONAL SEEDING, FERTILIZING, AND MULCH, TYPE 6	269	SY
8	9010-108-B	TEMPORARY HYDRAULIC SEEDING AND MBFM (SUDAS TYPE 4)	2,470	SY
9	9010-108-B	PERMANENT HYDRAULIC SEEDING, FERTILIZING, AND MBFM (SUDAS NATIVE GRASSES AND WILDFLOWERS)	2,200	SY
10	9010-108-E	WARRANTY, 3 YEAR ESTABLISHMENT AND MAINTENANCE	1	LS
11	9040-108-A-1	SWPPP PREPARATION	1	LS
12	9040-108-A-2	SWPPP MANAGEMENT	1	LS
13	9040-108-E	TEMPORARY RECP, TYPE 3B, NATURAL FIBER ONLY	494	SY
14	9040-108-J	RIP RAP, CLASS E	440	TON
15	9040-108-J	RIP RAP, CLASS E, SOIL CHOKED	50	TON
16	9040-108-J	MACADAM STONE	275	TON
17	9040-999-A	LIMESTONE CROSS VANE	29	EA
18	9040-108-O-1	STABILIZED CONSTRUCTION ENTRANCE	1	EA
19	9040-108-T-1	INLET PROTECTION DEVICE	4	EA
20	9040-108-T-2	INLET PROTECTION DEVICE, MAINTENANCE	4	EA
DIVISION 11	- SITE WORK	AND EROSION CONTROL		
21	11010-A	CONSTRUCTION SURVEY	1	LS
22	11020-A	MOBILIZATION	1	LS

FINAL PLANS



TRIBUTARY TO INDIAN CREEK (PROJECT B)
CITY OF NEVEDA
NEVADA, IOWA

GENERAL QUANTITIES

SHEET NO.

DIVISION 1	- GENERAL	
	1070-206-A	TEMPORARY TRAFIC CONTROL
		A CONTRACTOR TO PLACE TEMPORARY TRAFFIC CONTROL INORDER TO ALLOW FOR NORMAL USE OF ROADS IN ACCORDANCE WITH SUDAS
IVISION 2	- EXCAVATION	
	2010-108-C	CLEAR AND GRUBBING, TREE, BRUSH, AND ROCK REMOVAL
		A CONTRACTOR TO FURNISH ALL TOOLS, EQUIPMENT, LABOR AND MATERIALS NECESSARY TO CLEAR AND GRUBBING IN COMPLIANCE WITH THE CONTRACT DOCUMENTS
		B. INCLUDES REMOVAL AND LEGAL DISPOSAL OF TREES, SHURBS, OR OTHER MATERIALS AND PLACEMENT OF BACKFILL IN AREA WHERE ROOTS HAVE BEEN REMOVED C. PROTECTION OF TREES AND SHURBS TO REMAIN SHALL BE INCIDENTAL TO THIS ITEM. CONTRACTOR IS NOT TO CLEAR AND GRUB
		OUTSIDE OF THE CONSTRUCTION LIMITS NOTED ON THE PLAN AND PROFILE SHEETS. ONLY THE MINIMUM CLEARING AND GRUBBING TO TAKE PLACE AS NECESSARY TO COMPLETE THE PROJECT D. ALL MATERIAL THAT IS REMOVED FROM THE PROJECT, EXCEPT THERE UNDER 3B, SHALL BECOME THE PROPERTY OF THE CONTRACTOR. BURNING AND BURIAL ON THE PROJECT SITE IS NOT ALLOWED. REMOVAL OF MISCELLANEOUS DEBRIS AND TRASH SHALL BE CONSIDERED INCIDENTAL
,	2010-108-D-1	TOPSOIL, ONSITE, 6-INCH DEPTH (STRIP, SALVAGE, AND RESPREAD)
		A TOPSOIL TO BE STRIPPED, SALVAGED, AND APPLIED (6 INCH MINIMUM) WITHIN NEWLY GRADED AREAS BEFORE SEEDING B. ANY EXCESS TOPSOIL IS THE PROPERTY OF THE OWNER AND TO BE STOCKPILED AT A LOCATION ON-SITE AT THE DISCRETION OF THE OWNER.
		C. ADEQUATE EROSION CONTROL MEASURES FOR STOCKPILED SOIL SHALL BE PROVIDED BY THE CONTRACTOR, AND ARE INCIDENTAL TO THIS BID ITEM
	2010-108-E	EXCAVATION, CLASS 13, HAUL OFF-SITE
		A ITEM TO ONLY BE USED AT THE DIRECTION OF THE OWNER. B. CONTRACTOR WILL NOT BE PAID FOR HAUL-OFF EXCAVATION WITHOUT PRIOR PERMISSION FROM THE OWNER AND AGREEMENT ON QUANTITY. C. ITEM TO BE MEASURED BY TRUCK LOAD.
	2010 100 5	EVALUATION OF 100 to DESCRIPTION
	2010-108-E	EXCAVATION, CLASS 13, RESPREAD OFF-SITE A CAD QUANTITIES: CUT = 320 CY & FILL = 132 CY
		B. RESPREAD ON-SITE = CUT + ROCK VOL REUSE ONSITE = 320 + 498 - 178 = 640 CY C. EXCAVATION QUANTITIES ESTIMATED COMPARING EXISTING SURFACE TO PROPOSED SURFACE AND A 1.35 FILL FACTOR D. IT IS THE INTENTION TO RESPREAD OR STOCKPILE ALL EXCESS SOIL AT 445 11TH STREET. HOWEVER, IF ANY SOIL IS DEEMED UNDESIRABLE BY THE OWNER DUE TO EXCESS ROOTS, ROCK, DEBRIS, ETC. THIS SOIL WILL BE HAULED OFF-SITE IN A SEPARATE BID ITEM (ITEM 4). THE CONTRACTOR WILL BE PAID PLAN QUANTITY LESS THE VOLUME OF SOIL THAT IS DEEMED UNSUITABLE AND TRANSFERRED TO ITEM 4.
3	2010-108-E	EXCAVATION, CLASS 13, REUSE ON-SITE
		A CAD QUANTITIES: CUT = 320 CY & FILL = 132 CY B. REUSE ONSITE = 1.35 X FILL = 1.35 X 132= 178 C. EXCAVATION QUANTITIES ESTIMATED COMPARING EXISTING SURFACE TO PROPOSED SURFACE AND A 1.35 FILL FACTOR D. CONTRACTOR SHALL BE PAID THE PLAN QUANTITY
DIVISION 9	- SITE WORK AN	D EROSION CONTROL
	9010-108-A	PERMANENT CONVENTIONAL SEEDING, FERTILIZING, AND MULCH, TYPE 6
		A CONTRACTOR TO USE THE TYPE 6 MIXTURE ACCORDING TO SUDAS B. THE CONTRACTOR SHALL WATER THE SEEDED AREAS NO LESS THAN TWICE PER WEEK FOR THE FIRST TWO WEEKS, NO LESS THAN ONCE PER WEEK FOR THE NEXT TWO WEEKS, AND AS NECESSARY UNTIL SEEDED AREA IS ACCEPTED BY THE OWNER C. WATERING IS INCIDENTAL AND NO SEPARATE PAYMENT SHALL BE MADE D. CONTRACTOR TO OBTAIN SEED BED PREP APPROVAL PRIOR TO SEEDING E. TO BE PAID PLAN QUANTITY F. THIS INCLUDES SEEDBED PREP BUT IS NOT LIMITED TO SMOOTHING AND RUTTING OF RESTORATION OF TOPSOIL G. IMMEDIATELY COVER ALL SEEDED AREAS WITH MULCH AND RECP
3	9010-108-B	TEMPORARY HYDRAULIC SEEDING AND MBFM (SUDAS TYPE 4)
	33.0 130 2	A CONTRACTOR TO USE THE TYPE 4 MIXTURE ACCORDING TO SUDAS B. THE CONTRACTOR SHALL WATER THE SEEDED AREAS NO LESS THAN TWICE PER WEEK FOR THE FIRST TWO WEEKS, NO LESS THAN ONCE PER WEEK FOR THE NEXT TWO WEEKS, AND AS NECESSARY UNTIL SEEDED AREA IS ACCEPTED BY THE OWNER C. WATERING IS INCIDENTAL AND NO SEPARATE PAYMENT SHALL BE MADE D. CONTRACTOR TO OBTAIN SEED BED PREP APPROVAL PRIOR TO SEEDING
		E. TO BE PAID PLAN QUANTITY F. THIS INCLUDES BUT IS NOT LIMITED TO SMOOTHING AND RUTTING OF RESTORATION OF TOPSOIL G. ITEM IS ONLY NEEDED IF PERMANENT SEEDING CAN NOT BE COMPLETED WITHIN THE SUDAS SPECIFIED SEEDING WINDOW H. ITEM ONLY INTENDED FOR USE IF SEEDING WINDOWS CAN NOT BE MET FOR PERMANENT SEEDING. CONTRACTOR TO OBTAIN PERMISSION FROM OWNER OR ENGINEER PRIOR TO APPLICATION.
)	9010-108-B	PERMANENT HYDRAULIC SEEDING, FERTILIZING, AND MBFM (SUDAS NATIVE GRASSES AND WILDFLOWERS)
		A CONTRACTOR TO USE THE NATIVE GRASSES MIXTURE ACCORDING TO SUDAS B. THE CONTRACTOR SHALL WATER THE SEEDED AREAS NO LESS THAN TWICE PER WEEK FOR THE FIRST TWO WEEKS, NO LESS THAN ONCE PER WEEK FOR THE NEXT TWO WEEKS, AND AS NECESSARY UNTIL SEEDED AREA IS ACCEPTED BY THE OWNER C. WATERING IS INCIDENTAL AND NO SEPARATE PAYMENT SHALL BE MADE D. CONTRACTOR TO OBTAIN SEED BED PREP APPROVAL PRIOR TO SEEDING E. TO BE PAID PLAN QUANTITY F. SEED BED PREP INCLUDES BUT IS NOT LIMITED TO SMOOTHING AND RUTTING OF RESTORATION OF TOPSOIL G. SEEDING TO BE COMPLETED IN THE ARPIL 1.2 JUNE 30 SEEDING WINDOW.
		G. SEEDING TO BE COMPLETED IN THE APRIL 1 - JUNE 30 SEEDING WINDOW H. CONTRACTOR SHALL SUBMIT A LETTER OF CONFIRMATION OF SEED VARITIES AND MATERIAL SOURCE PRIOR TO PROCUREMENT AND INSTALLATION I. CONTRACTOR TO PROVIDE PROOF OF 5 PROJECTS USING NATIVE PLANTS OR UTILIZE QUALIFIED SUB

ESTIMATE REFERENCE INFORMATION


ITEM NO	ITEM CODE	ESTIMATE REFERENCE INFORMATION
ITEM NO. 10	9010-108-E	ITEM DESCRIPTION
10	3010-100-E	WARRAN I Y, 3 YEAR ESTABLISHMENT AND WAINTENANCE A DURING THE ESTABLISHMENT WINDOW A QUALIFIED NATIVE PLANT SPECIALIST WILL MONITOR THE SITE 3 TIMES IN YEAR 1 AND 2 TIMES IN YEARS 2 AND 3 AND PROVIDE AN ESTABLISHEMENT REPORT THAT INCLUDES MAINTENANCE ITEMS PERFORMED AND %
		COVERAGE B. SATISFACTORY ESTABLISMENT INCLUDES 70% COVERAGE AFTER 1 GROWING SEASON, 90% COVERAGE AFTER 2 GROWING
		SEASONS, AND 95% COVERAGE AFTER 3 GROWING SEASONS C. YEAR 1 ESTABLISHMENT ITEMES INCUDE: MOWING "KNEE HIGH" (UNDER 4 FT) TO 6" THROUGHOUT JUNE, JULY, AND AUGUST,
		SPARING APPLICATION OF HERBICIDES AS NEEDED D. YEAR 2 ESTABLISHMENT ITEMS INCLUDE: MOWING 1 TIME ONCE WEEDS ARE 3-4 FT TALL TO AND 8-12" HEIGT E. YEAR 3 PRESCRIBED BURN ACCORDING TO EXHIBIT 11-4-1 "PRESCRIBED BURN SCHEDULE" IN THE ISWMM DOCUMENTATION
		F. ITEM DOES NOT INCLUDE RE-SEEDING. CONTRACTOR WILL NOTIFY CITY AND ENGINEER IF RESEEDING IS NEEDED. UNIT COST FOR RESEEDING SHAL NOT EXCEDE ORIGINAL NATIVE SEEDING COSTS G. CONTRACTOR TO FOLLOW MAINTENANCE GUIDE PROVIDED IN CONTRACT DOCUMENTS
11	9040-108-A-1	SWPPP PREPARATION
		A FINAL SWPPP TO BE APPROVED BY THE ENGINEER
12	9040-108-A-2	SWPPP MANAGEMENT
		A ITEM INCLUDES ALL WORK RELATED TO COMPLY WITH THE ADMINISTRATIVE PROVISIONS OF THE IOWA DNR NPDES GENERAL PERMIT NO. 2, INCLUDING RECORD KEEPING, DOCUMENTATION, UPDATING THE SWPPP, WEEKLY INSPECTIONS, FILING THE NOTE OF DISCONTINUATION, ETC.
		B. ITEM INCLUDES FURNISHING ALL TOOLS, EQUIPMENT, LABOR, AND MATERIALS NECESSARY TO COMPLY WITH THE SWPPP AS NEEDED FOR THE PROJECT. THIS MAY INCLUDE, BUT IS NOT LIMITED TO , INSTALLATION OF SILT FENCE AROUND SOIL STOCKPILES ANI APPLICATION OF WATER FOR DUST CONTROL AND STRAW MULCH IF INACTIVITY CONDITIONS ARE MET
13	9040-108-E	TEMPORARY RECP, TYPE 3B, NATURAL FIBER ONLY A ITEM TO BE NATURAL FIBER ONLY
		B. CONTRACTOR TO BE PAID PLAN QUANTITY
		C. TO BE PLACED IMMEDIATELY FOLLOWING SEEDING.
14	9040-108-J	RIP RAP, CLASS E
		A ITEM TO BE USED AS SHOWN FOR BED PROTECTION, RIPRAP APRONS, AND STONE TOE PROTECTION
		B. SEE SHEETS C.201-C.203 FOR PLAN AND PROFILE LOCATION
		C. REFER TO SHEETS C.502 AND C.503 FOR DETAILS D. NO PAYMENT OF THE ITEM ABOVE PLAN QUANTITY UNLESS PRE-APPROVED
		E. FILTER FABRIC IS INCIDENTAL
5	9040-108-J	RIP RAP, CLASS E, SOIL CHOKED
		A IN ARÉAS CALLÉU OUT AS SOIL CHOKED RIPRAP, PLACE RIP RAP AS NORMAL, FILL WITH A LIGHT LAYER OF SOIL, SEED, AND PLACE RECP
		B. NO PAYMENT OF THE ITEM ABOVE PLAN QUANTITY UNLESS PRE-APPROVED
		C. FILTER FABRIC IS INCIDENTAL D. ITEM TO BE DAID DI AN OLIANITITY
16	9040-108-J	MACADAM STONE
		A ITEM TO BE USED AS SHOWN BELOW BED PROTECTION AND TOE ROCK B. SEE SHEETS C.201-C.203 FOR PLAN AND PROFILE LOCATION
		C. REFER TO SHEETS C.502 FOR DETAILS
		D. NO PAYMENT OF THE ITEM ABOVE PLAN QUANTITY UNLESS PRE-APPROVED
		E. FILTER FABRIC IS INCIDENTAL
17	9040-999-A	LIMESTONE CROSS VANE
		A ITEM SHALL INCLUDE THE PLACEMENT OF 12" H, 24" D, 48" W LIMESTONE BLOCKS AS CHECK DAMS IN LOCATIONS SHOWN ON PLANS B. ITEM SHALL INCLUDE STONE BASE AND SUBGRADE PREP C. ITEM TO BE PAID PLAN QUANTITY UNLESS PRE APPROVED BY THE ENGINEER D. BLOCK SIZE AND PLACEMENT SUBJECT TO APPROVAL
18	9040-108-O-1	STABILIZED CONSTRUCTION ENTRANCE
		A ITEM INCLUDES FURNISHING AND INSTALLING ENGINEERING FABRIC BENEATH THE STONE MATERIAL B. CONTRACTOR TO FURNISH ALL TOOLS, EQUIPMENT, LABOR, AND MATERIALS NECESSARY TO INSTALL, MAINTAIN, AND REMOVE STABILIZED CONSTRUCTION ENTRANCES
		C. MINIMUM 6-INCH THICKNESS REQUIRED
9	9040-108-T-1	INLET PROTECTION DEVICE
		A ITEM SHALL INCLUDE THE INSTALLATION OF A FILTERSOCK WHERE SHOWN ON THE PLAN
20	9040-108-T-2	INLET PROTECTION DEVICE, MAINTENANCE
		A ITEM INCLUDES FURNISHING LABOR AND MATERIALS NEEDED TO CLEAR SEDIMENT FROM PROTECTION DEVICES AS NEEDED
		D EROSION CONTROL
21	11010-A	CONSTRUCTION SURVEY A ITEM INCLUDES ALL NECESSARY SURVEY, STAKING, AND LAYOUT TO CONSTRUCT THE PROJECT, BASED ON CONTROL POINTS
		ESTABLISHED BY DESIGN SURVEYOR
		B. ALL PROJECT STAKING IS CONSIDERED INCIDENTAL C. ITEM INCLUDES RESETTING AND FILING OF TIE CERTIFICATES OF ALL DISTURBED SECTION OR LOT CORNERS
	11020-A	MOBILIZATION
22		

FINAL PLANS

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TRIBUTARY TO INDIAN CREEK (PROJECT B)
CITY OF NEVEDA
NEVADA, IOWA

GENERAL

ERI NOTES - ESTIMATE REFERENCE

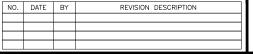

 $1 \frac{\text{CONTROL PLAN}}{\text{SCALE: 1' = 50'}}$

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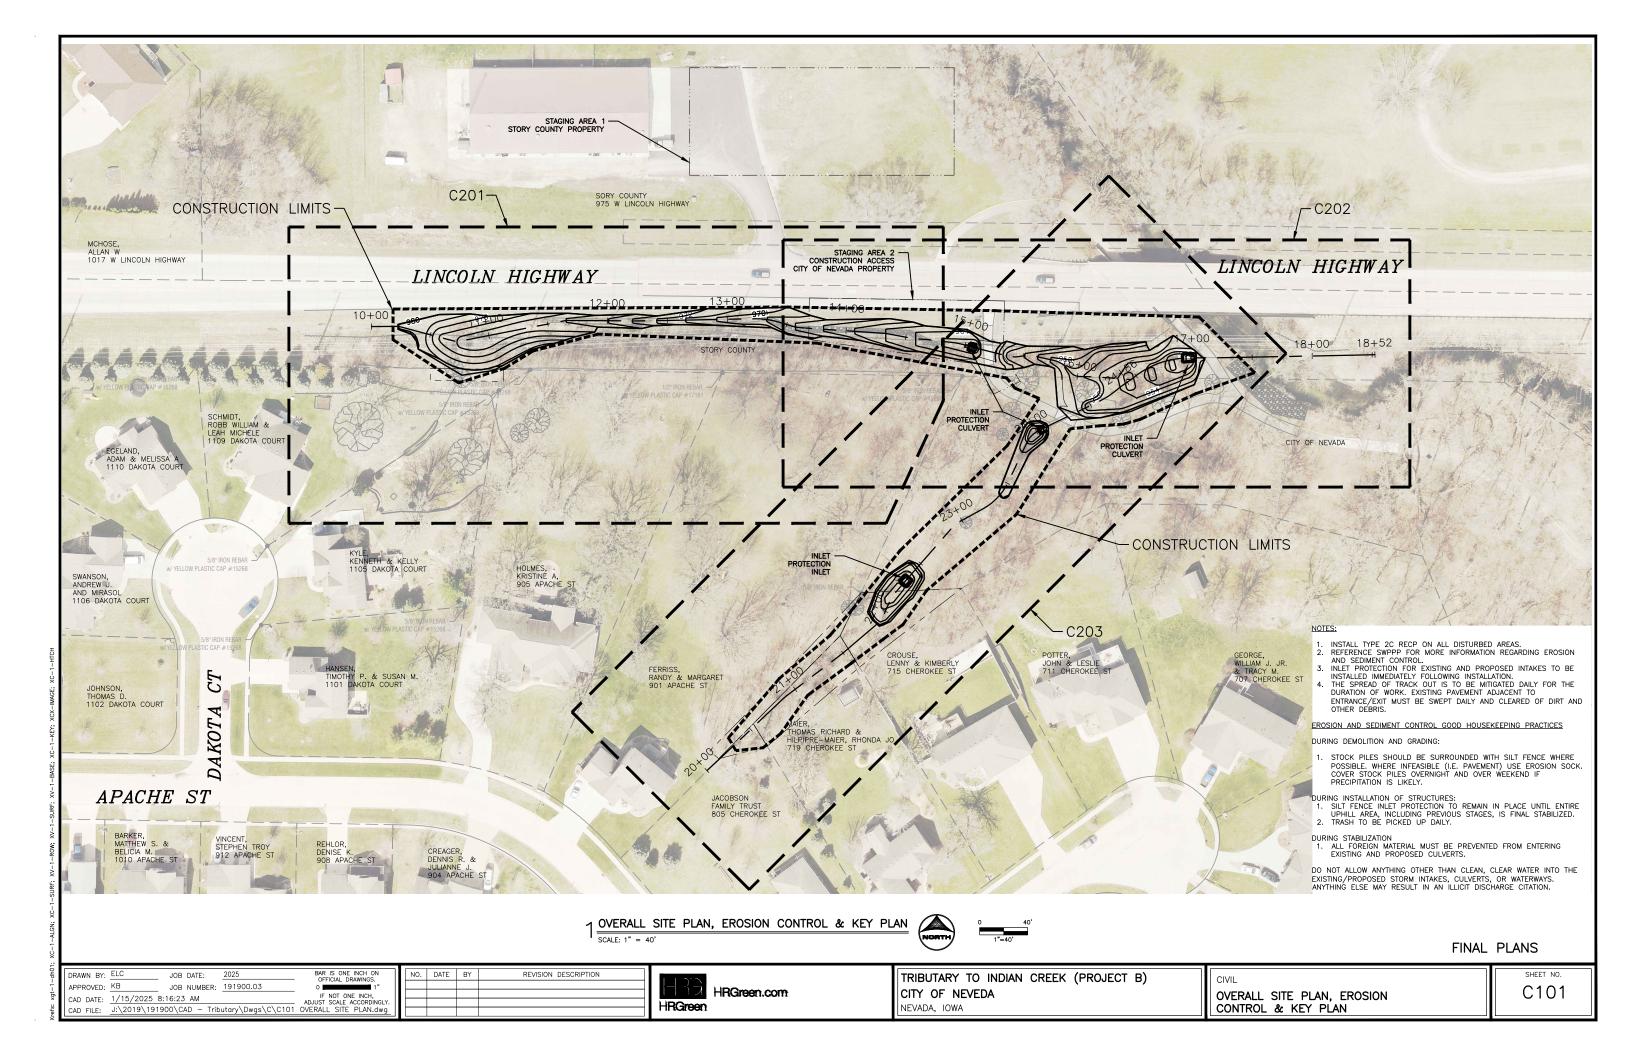



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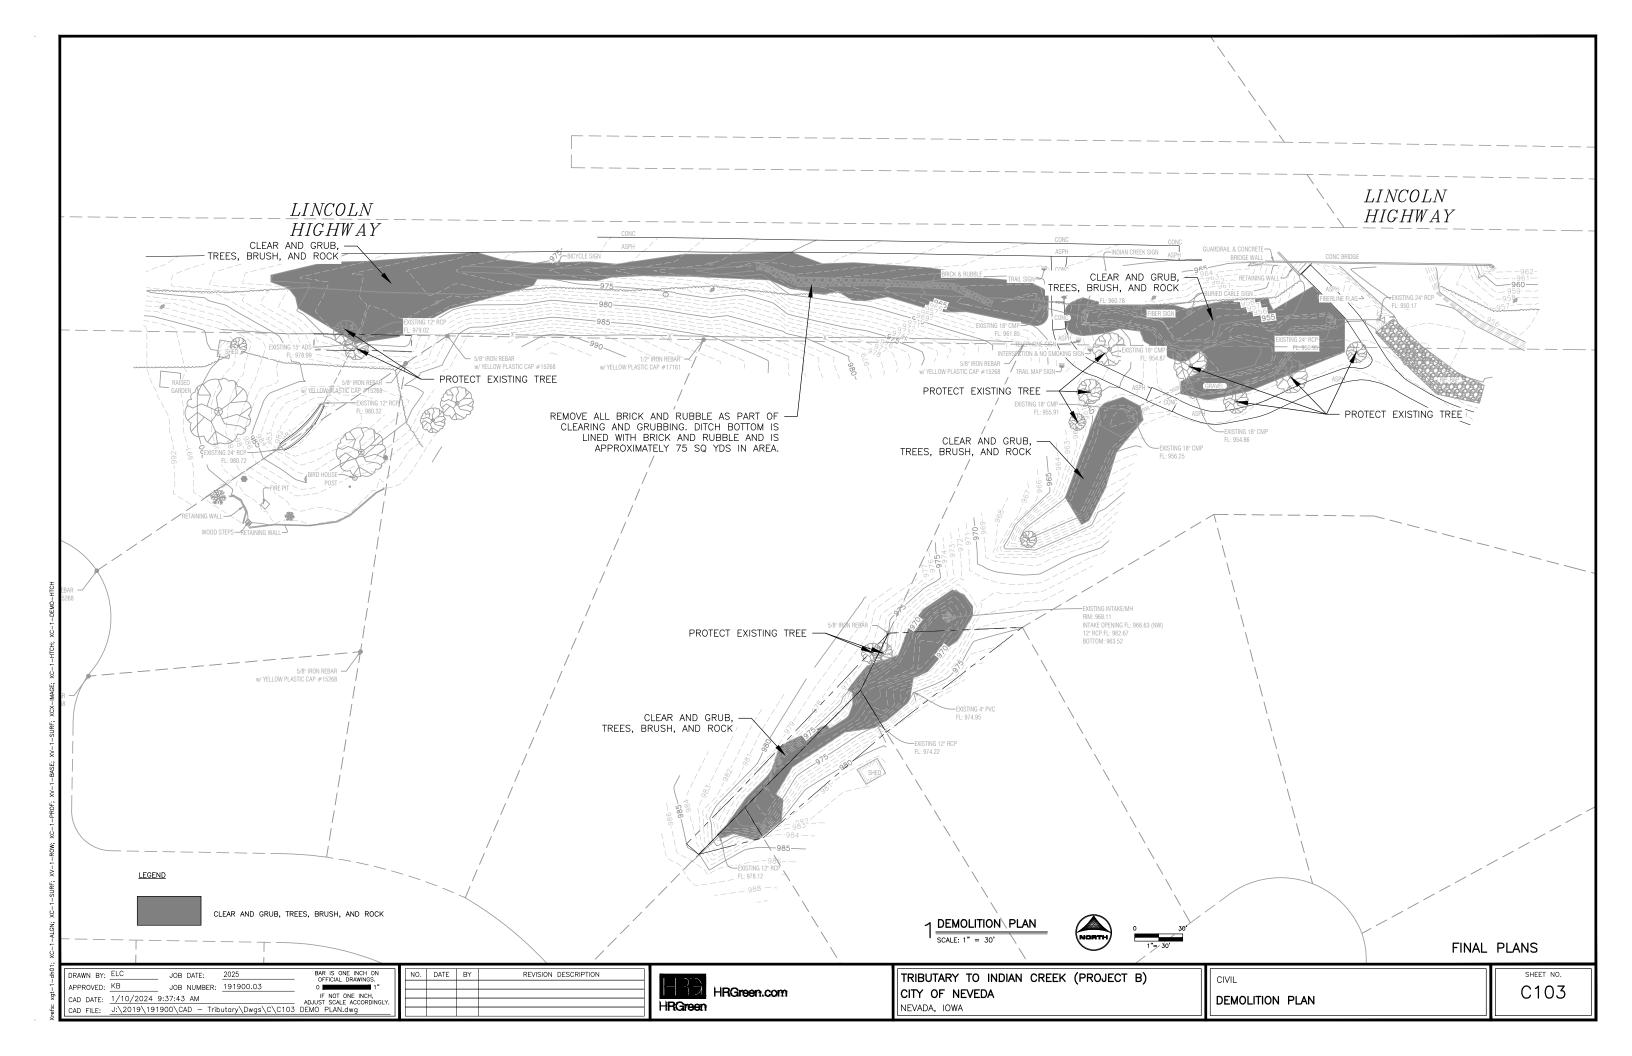
FINAL PLANS


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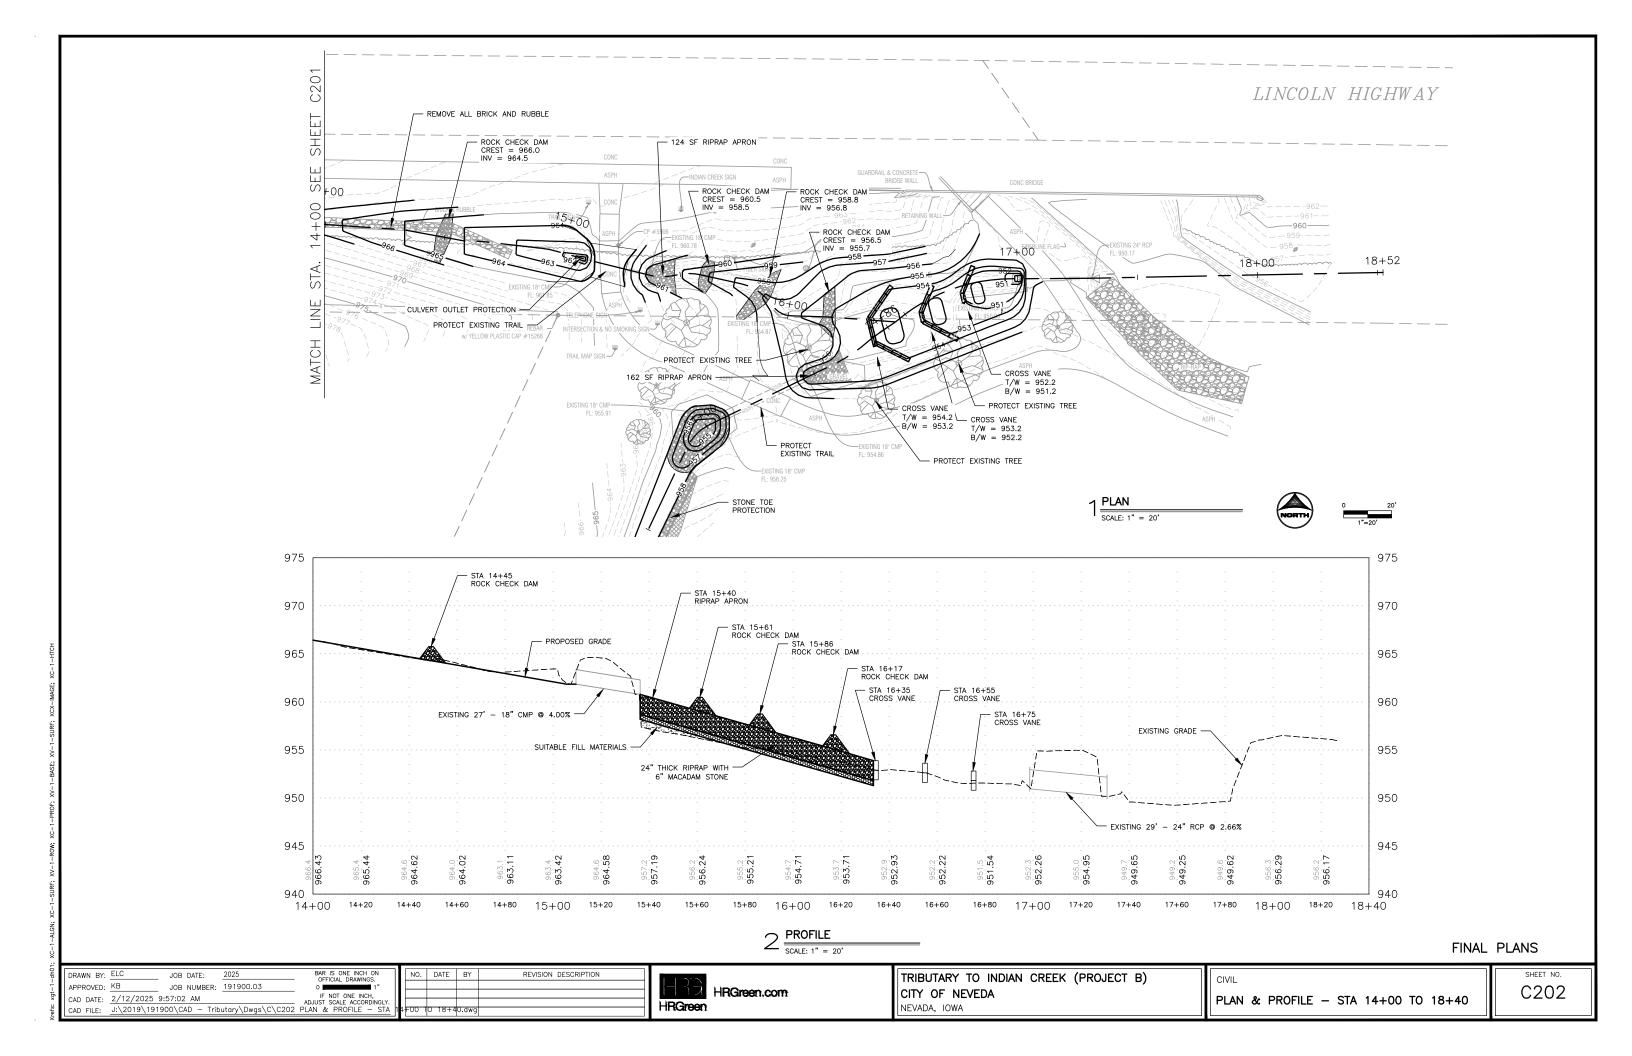
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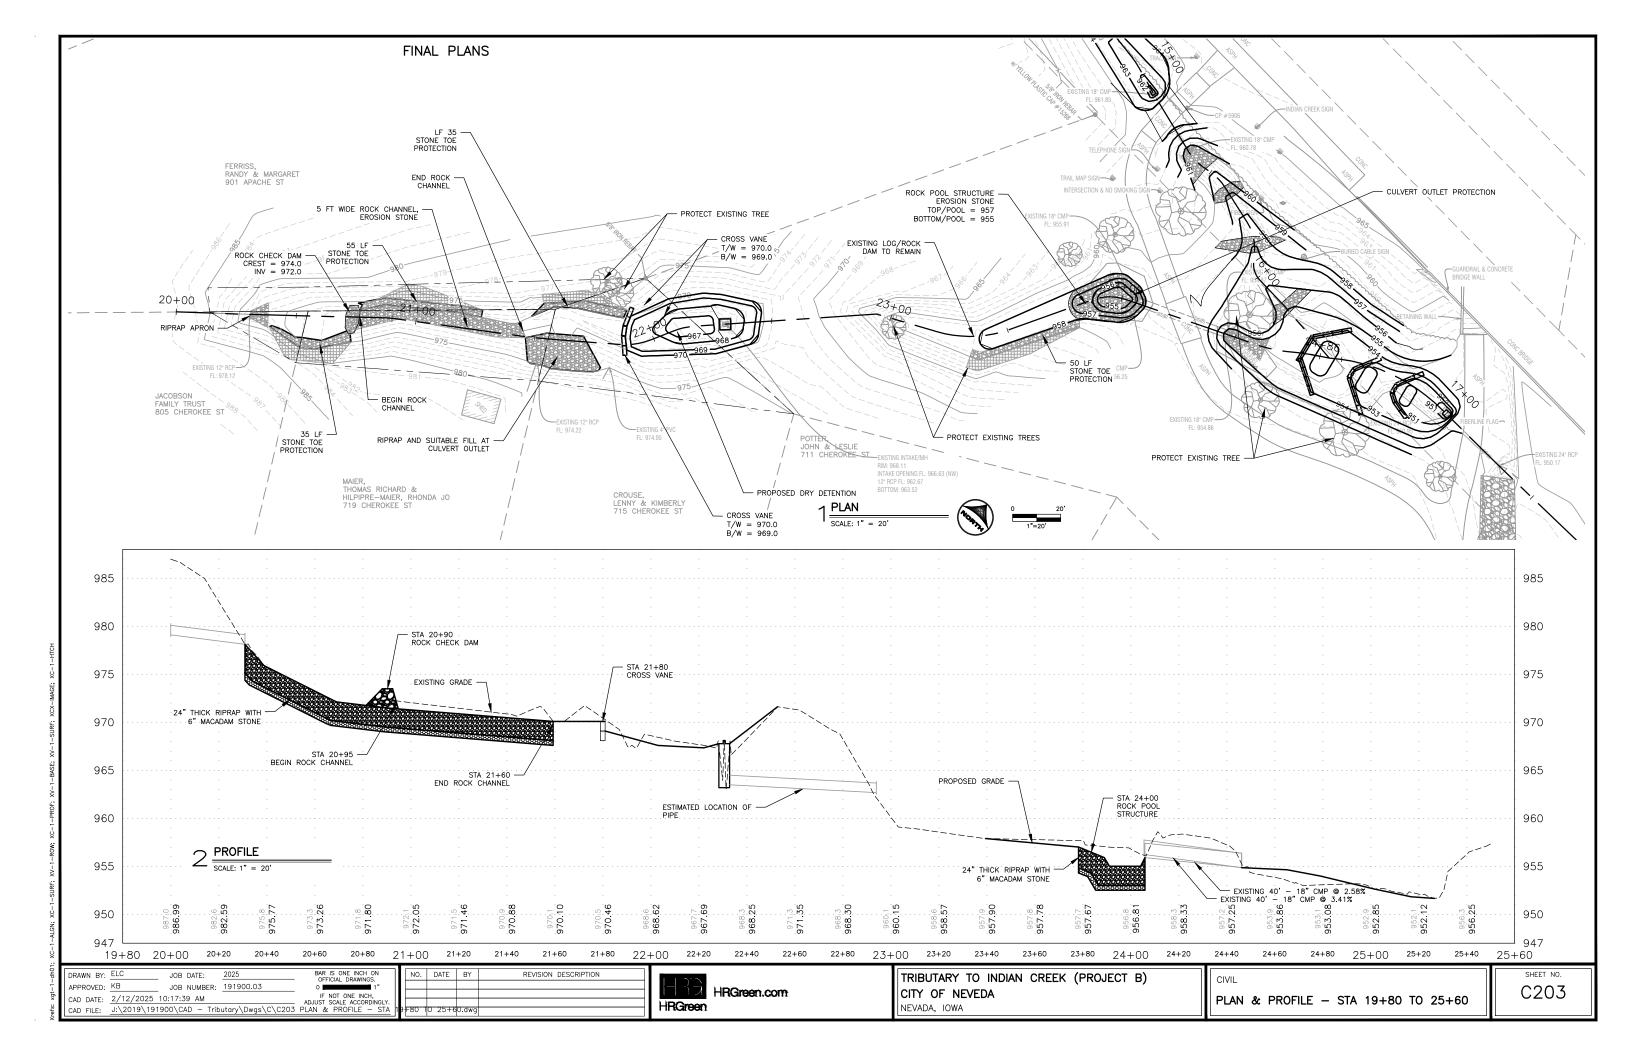








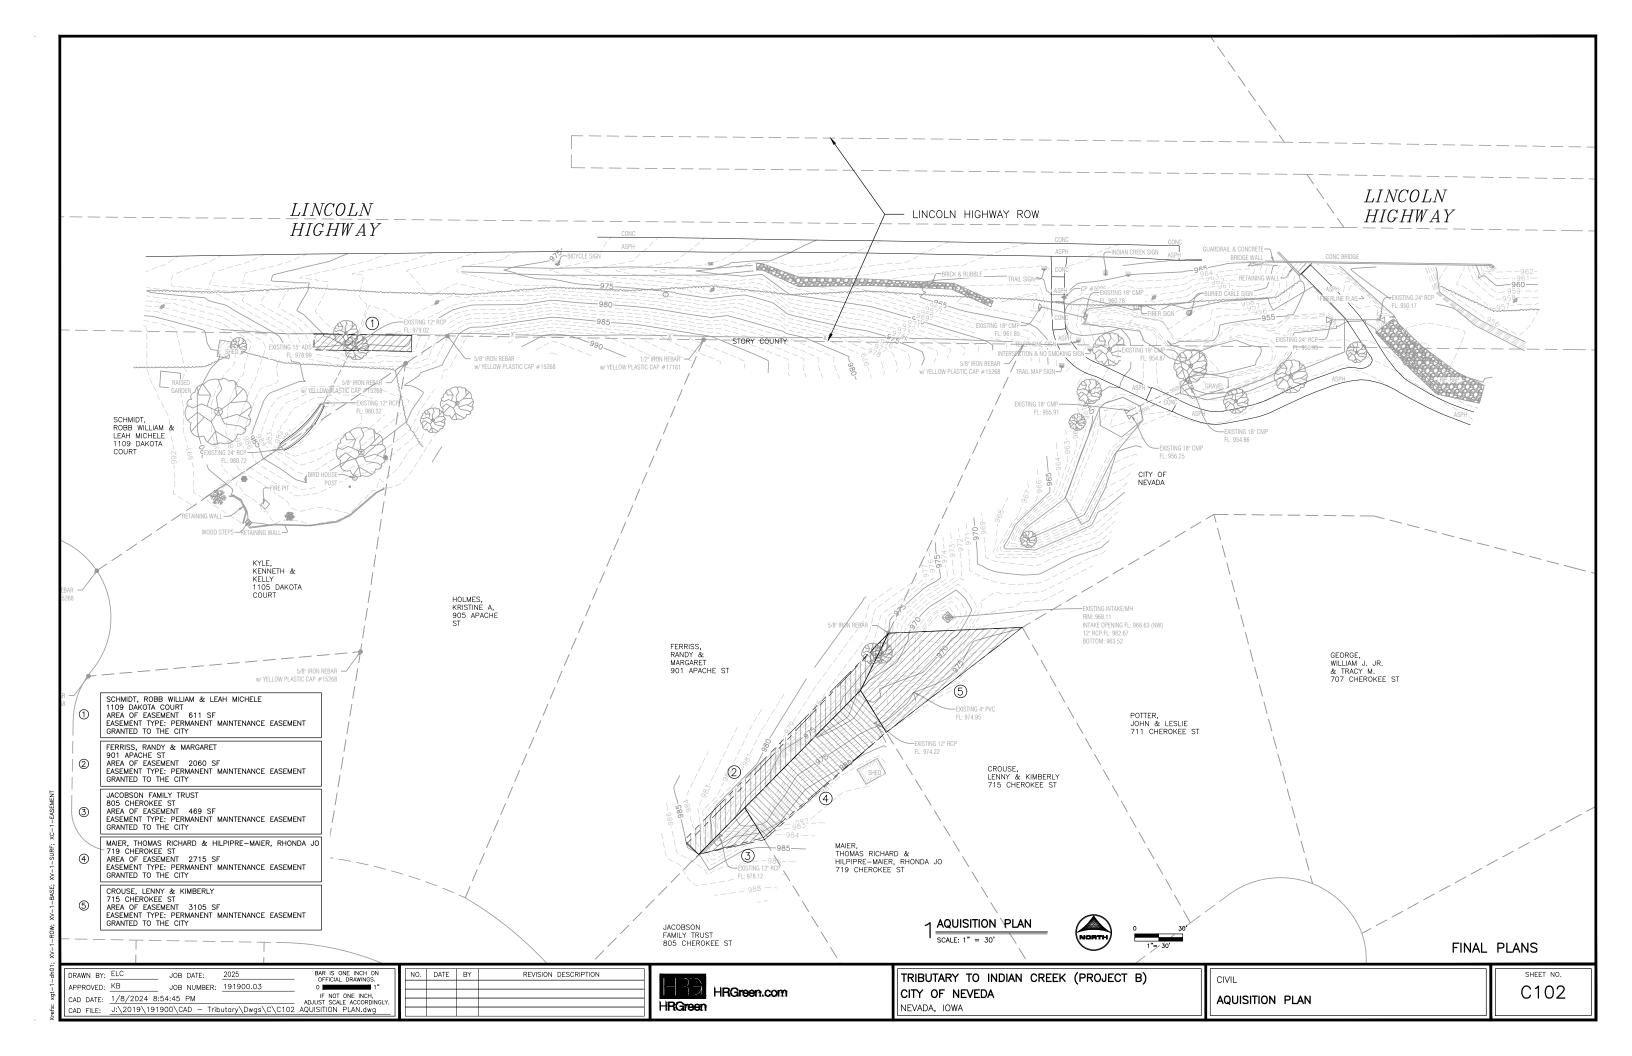

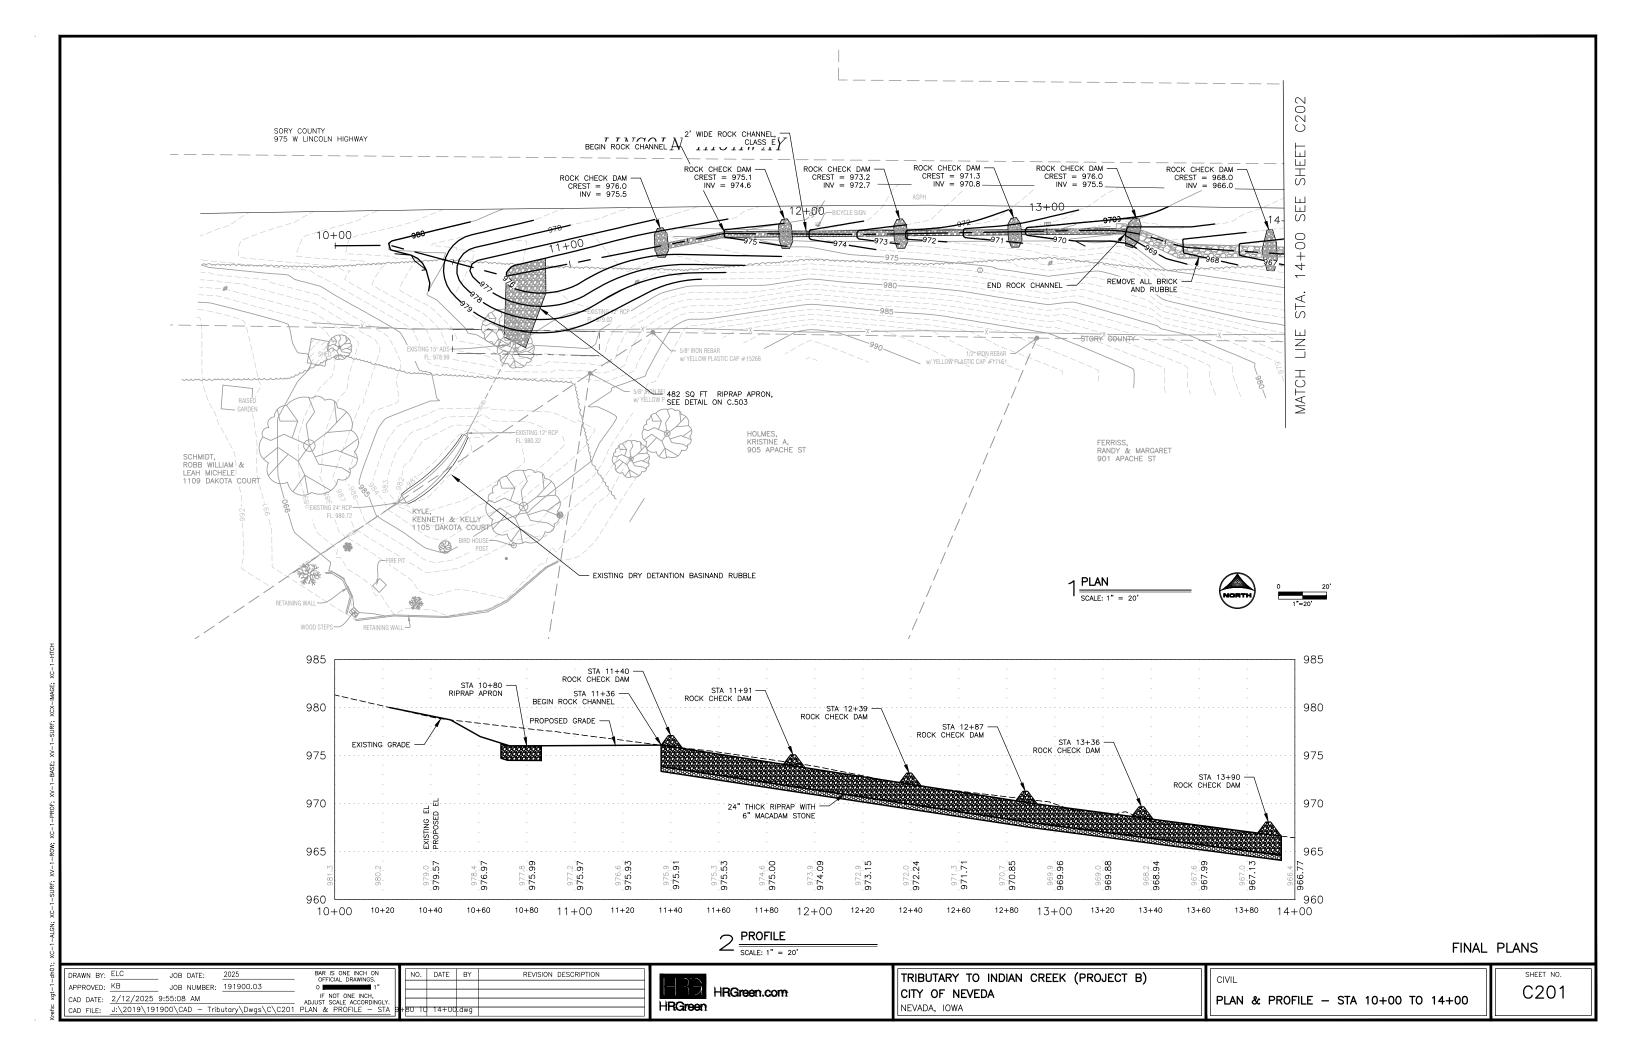

SALT RESISTANT GRASS MIX WITH TEMP RECP



SUDAS NATIVE GRASSES AND WILDFLOWERS

NO. DATE BY

REVISION DESCRIPTION



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APPROVED: KB

RIPRAP

FINAL PLANS

CIVIL


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RESTORATION - STA 9+80 TO 14+00

C204





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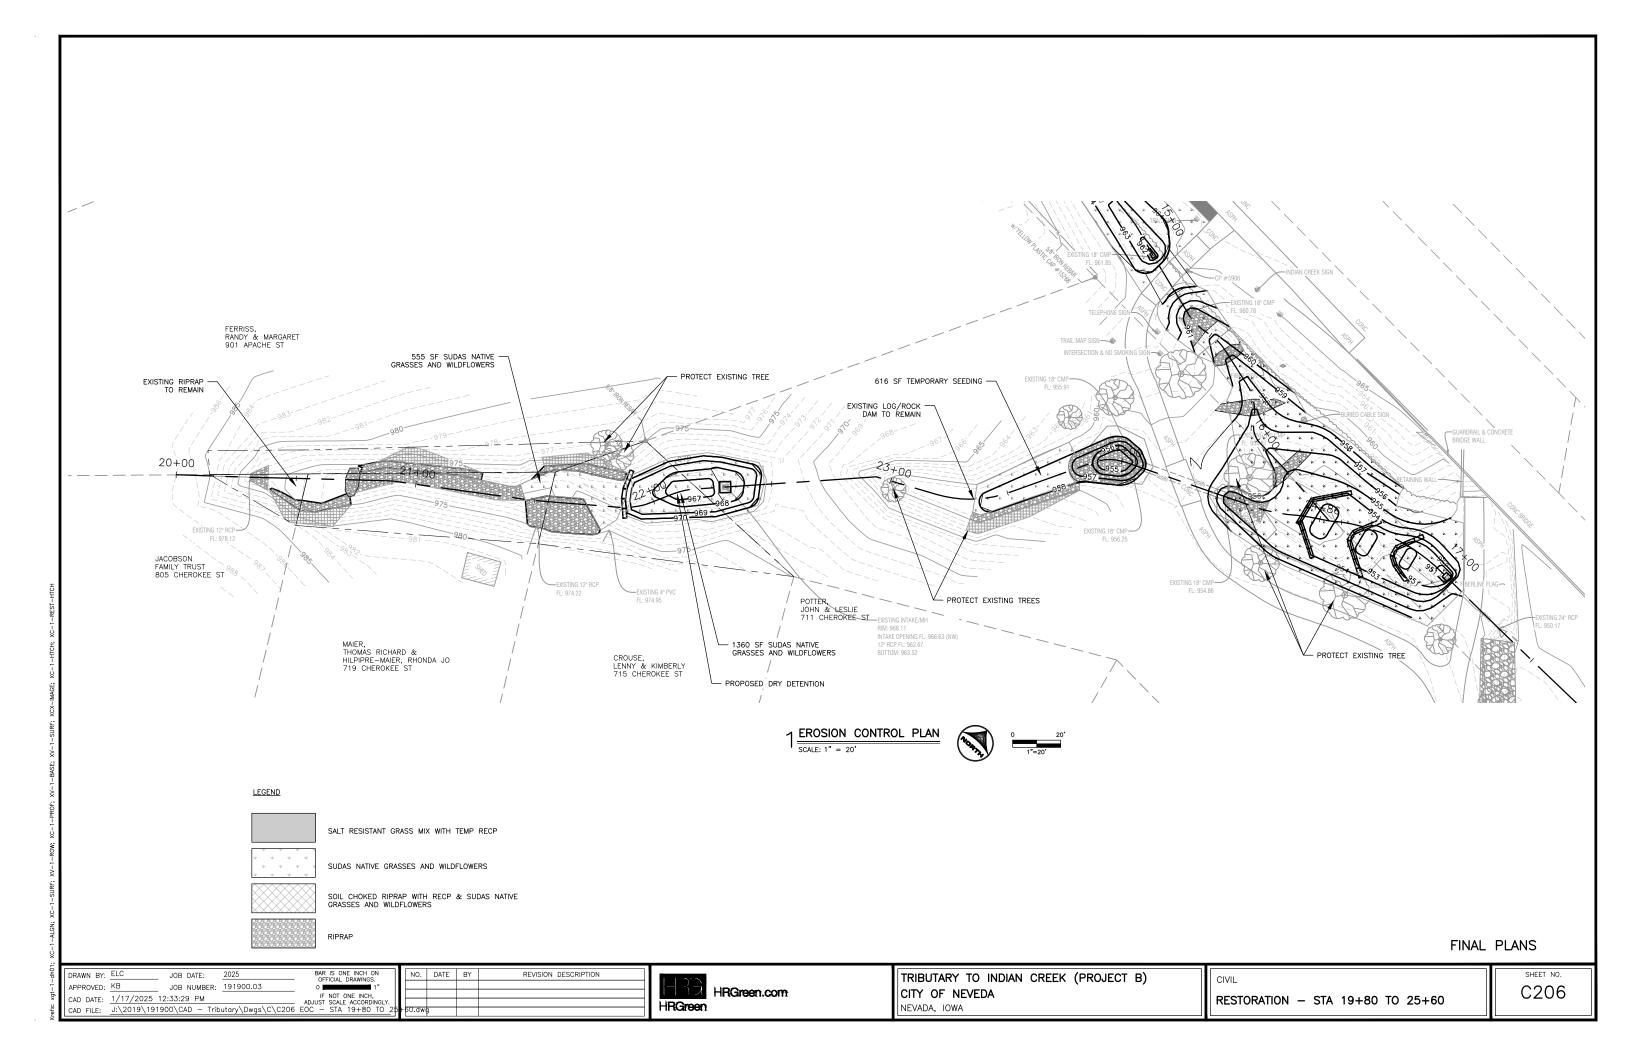
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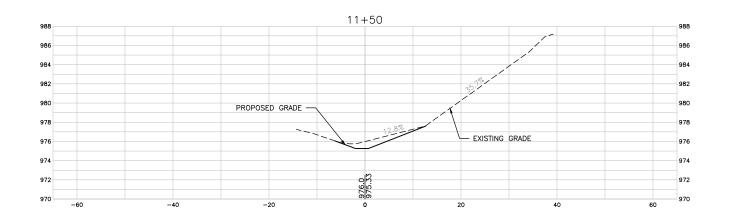
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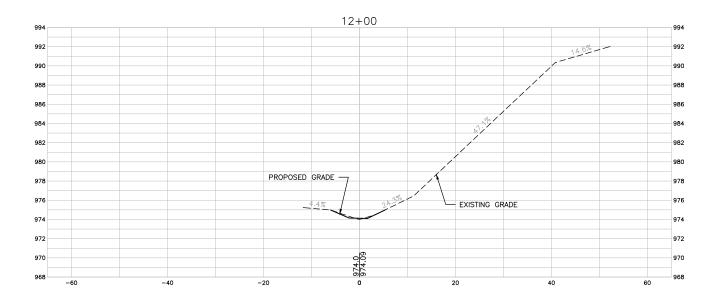
RESTORATION - STA 14+00 TO 18+40

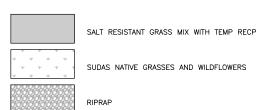
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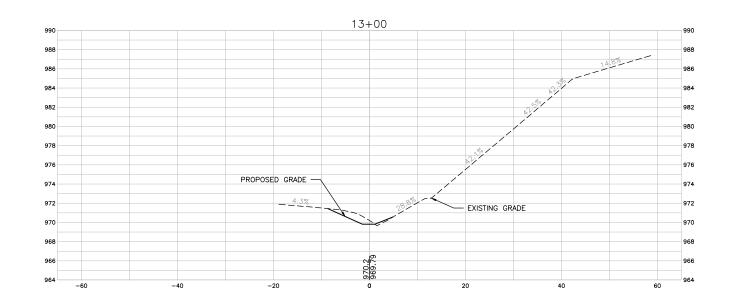
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 $1 \frac{\text{CROSS SECTIONS}}{\text{SCALE: 1"} = 10'}$

FINAL PLANS


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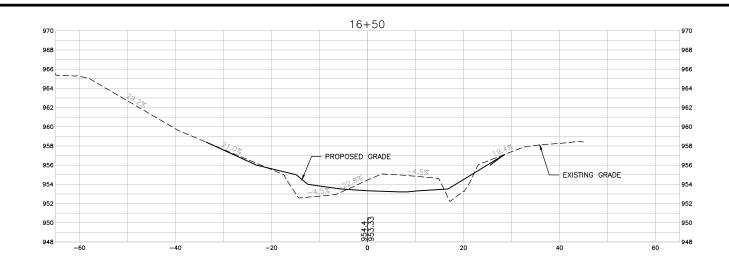



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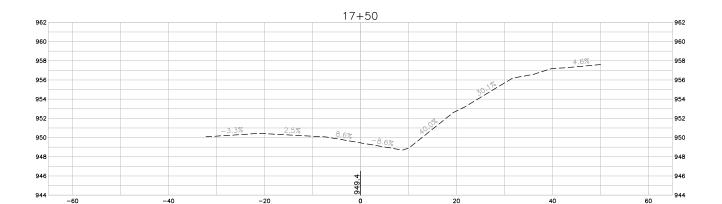
CROSS SECTIONS

SHEET NO.

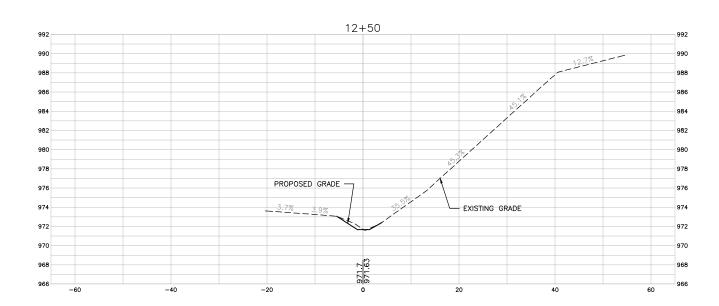



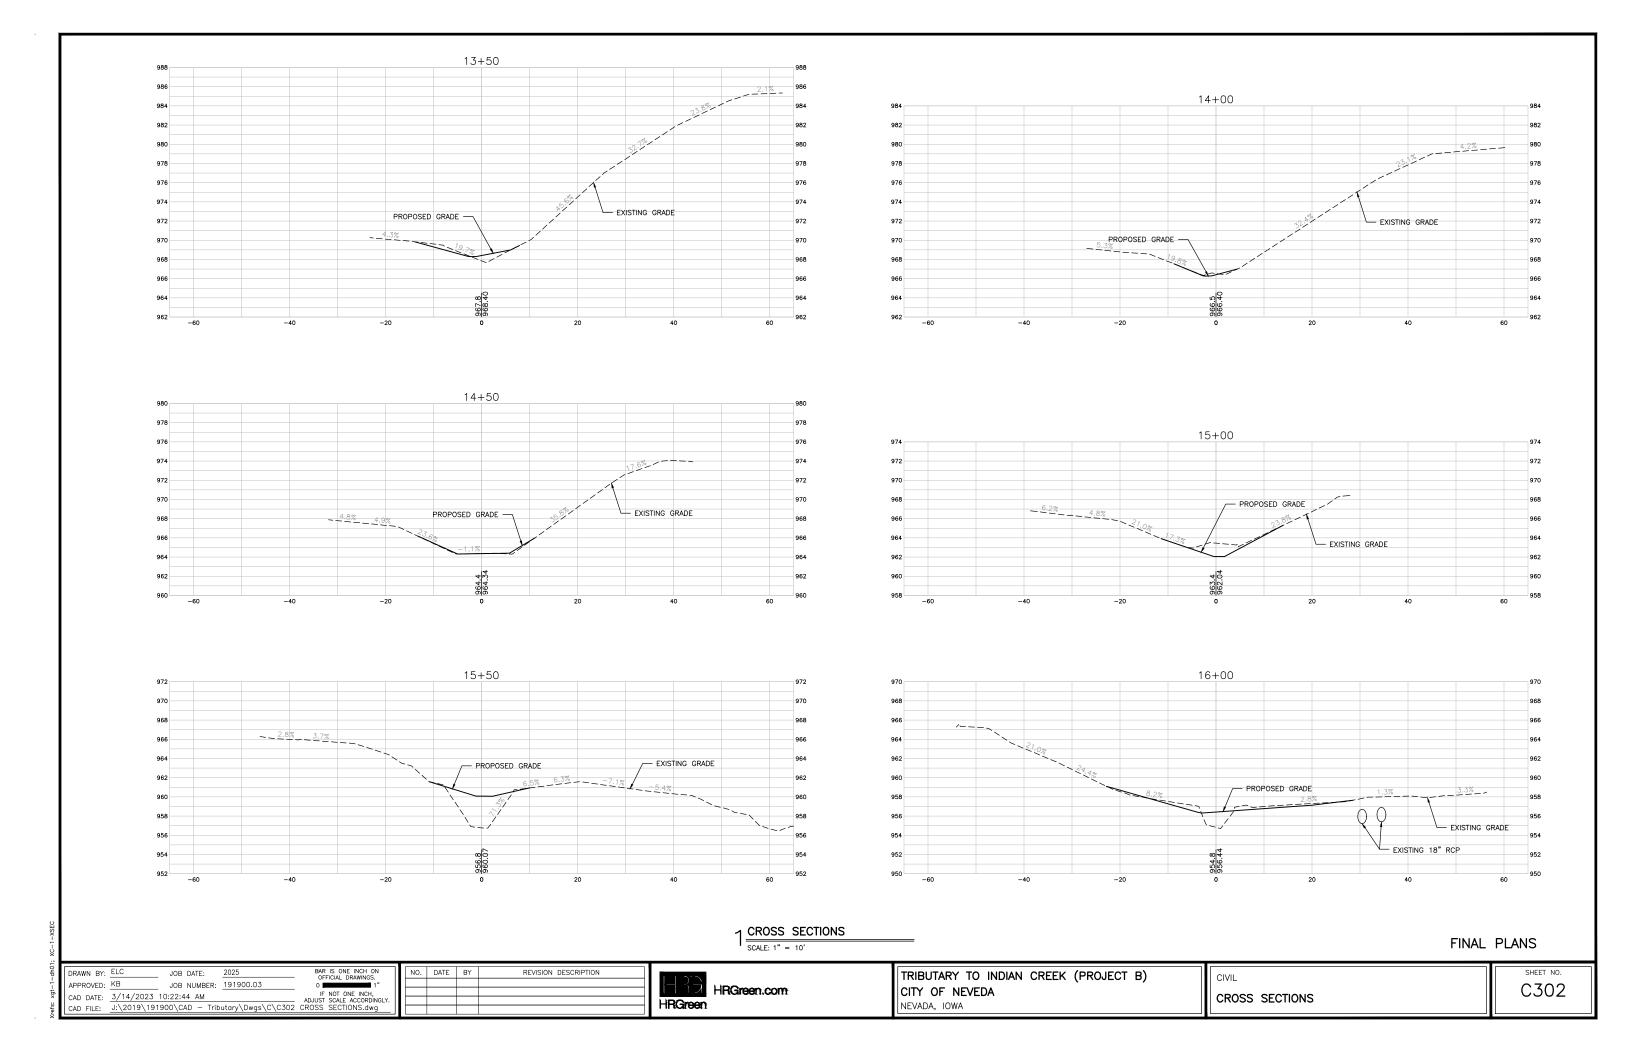

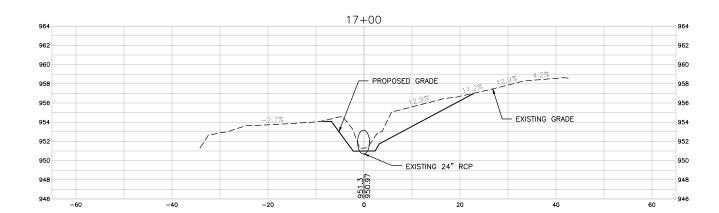

1 CROSS SECTIONS SCALE: 1" = 10'

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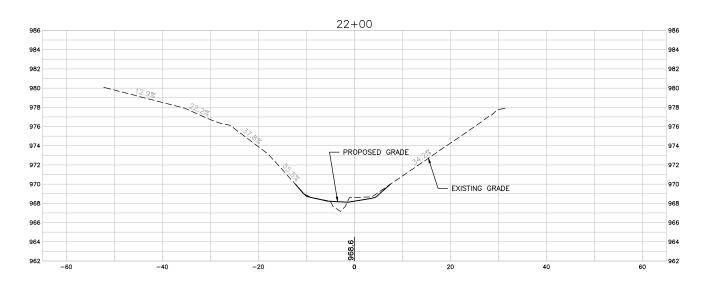
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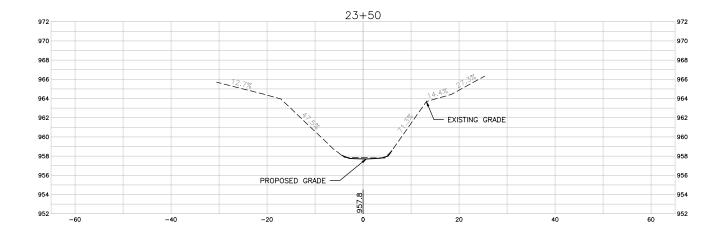
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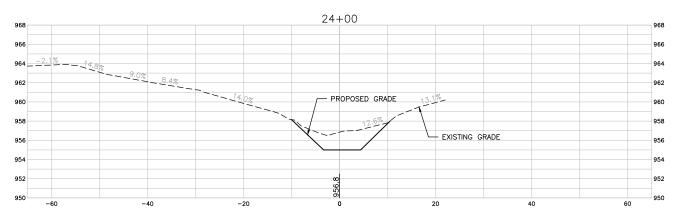
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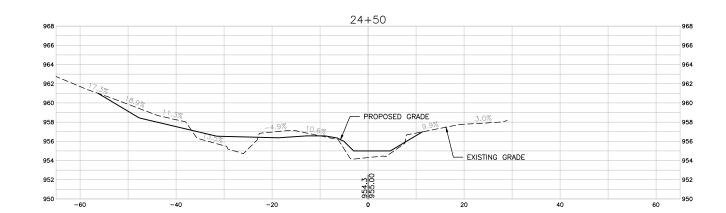
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NEVADA, IOWA

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CROSS SECTIONS


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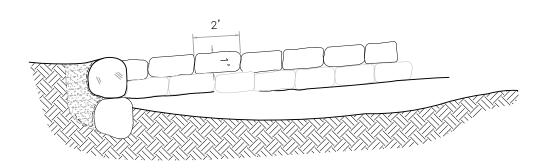
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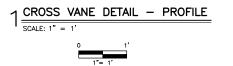
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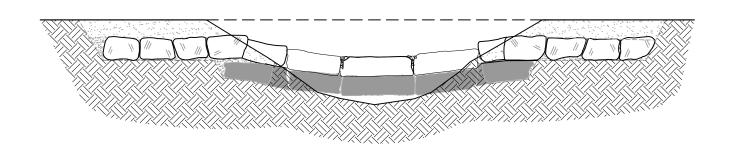
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1 CROSS VANE DETAIL - CROSS SECTION

SCALE: 1" = 1'

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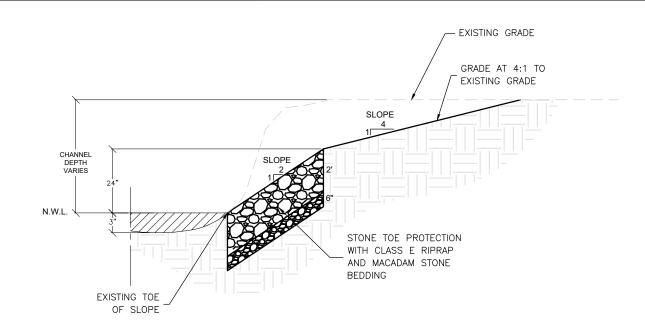


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CITY OF NEVEDA
NEVADA, IOWA


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CROSS VANE DETAIL

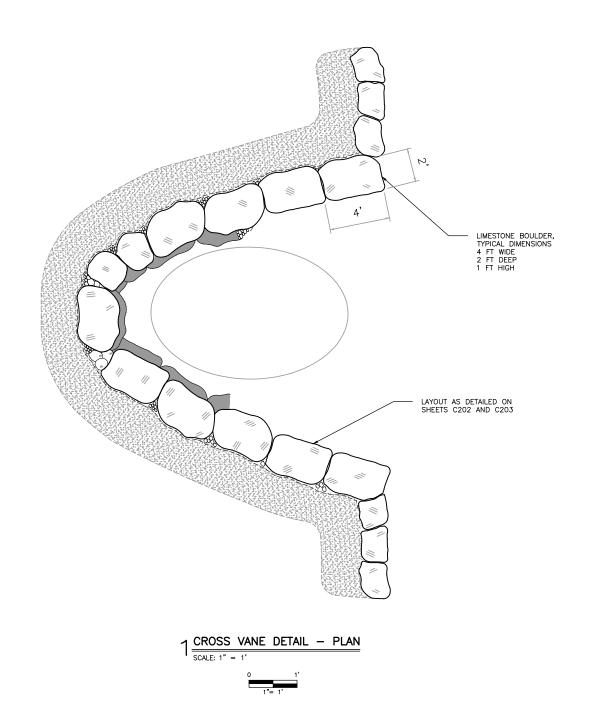
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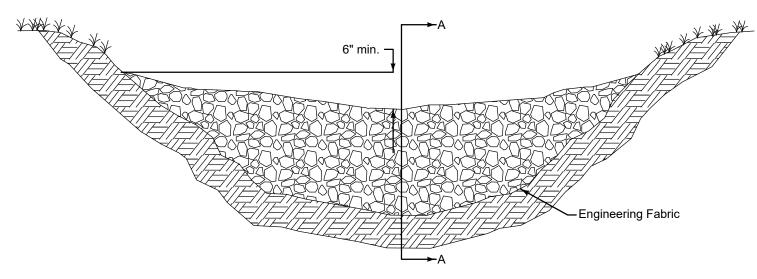



1 TYPICAL CHANNEL SECTION WITH STONE TOE PROTECTION



$3_{\frac{\text{TYPICAL CHANNEL SECTION WITH BANK SLOPE RESHAPING}}{\text{SCALE: N.T.S.}}}$

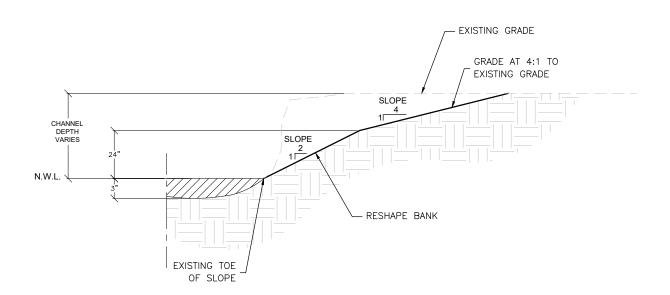

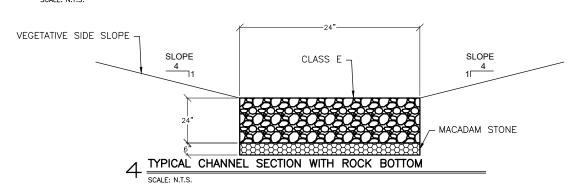

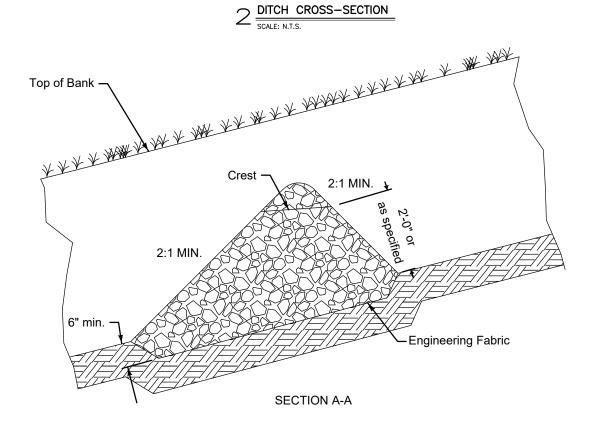

FINAL PLANS

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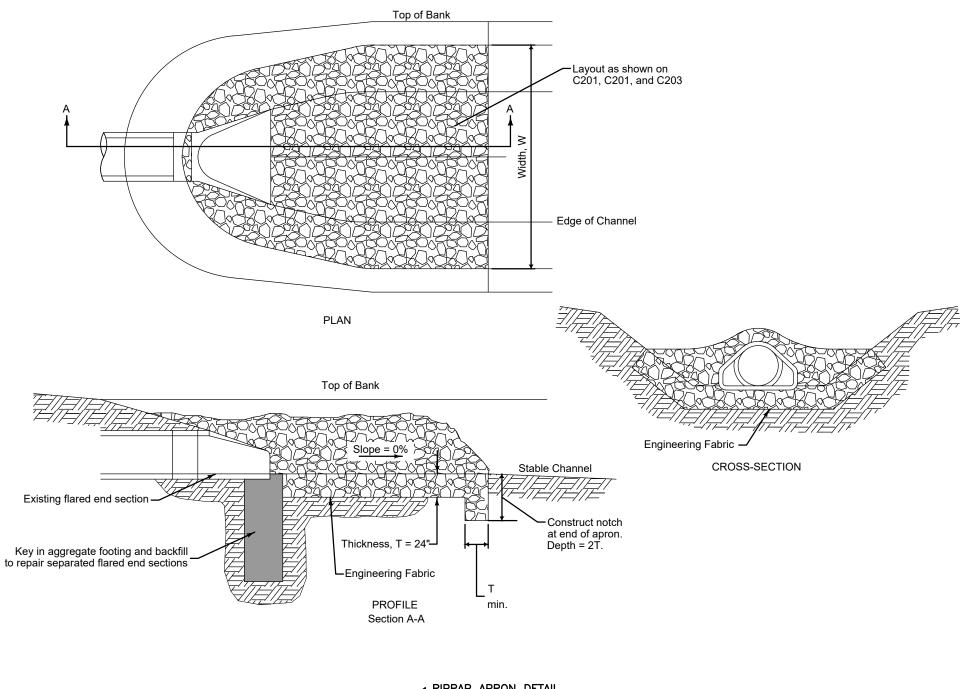


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CIVIL

STONE TOE PROTECTION DETAIL

SHEET NO. C502



1 RIPRAP APRON DETAIL

SCALE: N.T.S.

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RIPRAP APRON DETAIL

SHEET NO. C503